

PLANNED UNIT DEVELOPMENT (PUD) APPLICATION

An application fee and escrow deposit must accompany this form. See reverse side for fee schedule.

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Applicant Information:	
Name: Thornapple Pines Development	
Address: 660 Ada Dr Ada MI 49301	
Phone Number: 616 710-3245 Email: Chayte mensacap. con	1
Property Owner Name and Address (if different than above):	
TPR 7699 Face St LLC	
Property Information:	
Property Address: 7699 Fase 5+	
Parcel Number: 41 - 15 - 34 - 402 - 008	
Current Zone District Classification: $\frac{2-3}{}$	
Name of Project: Fase St Development	
Summary Description of Project: 16 Residential transing structures	
Summary Description of Project: 16 Residential transing structures to replace abandoned Road Commission building.	
Type of Application: Pre-Application Conference	
Preliminary PUD or Revised Preliminary PUD	
Final PUD	
Revised Final PUD	
I (we), the undersigned, do herby make application and petition the Township to amend the Ada Township Zoning Ordinance and associated zoning map and also herby grant permission to Ada Township and its official and staff to enter upon the subject property for purposes of review and evaluation of this request.	slc
Applicant's Signature(s):	
Property Owner's Signature(s): Date: (If different than above)	
TO BE COMPLETED BY ADA TOWNSHIP	
Application Received: Initial: mm / dd / yy	
Application Fee of \$Received:Initial: Check #Receipt # mm / dd / yy	=
Escrow Deposit of \$Received: Initial: Check # Receipt #	===

Narrative Statement

The Fase St Project is a development consisting of 16 single family home sites at the end of Fase St in the Village of Ada. The site is located in the vicinity of several residential neighborhoods but has been home to the Kent County Road Commission structure since the 1930's, primarily used as vehicle storage, maintenance, road salt storage, and various other activities. It is the intent of the applicant to create a niche neighborhood of moderate sized houses, on lots sized consistently with the required widths of the remainder of Fase St., which is compatible with the aesthetic of Fase St and with the goals of the Ada Master Plan.


Due to the very limited supply of housing, this project responds to a need of Greater Grand Rapids and Kent County to create attractive residential communities. According to the Bowen Research report in summer 2020, the single family for sale home availability rate in Kent County is <1%. A typical, healthy, availability rate is roughly 3%. The Fase St Development is also is consistent with the Ada Township Master Plan, specifically creating walkable neighborhoods and taking advantage of compact development design. This site is serviced by public water and sewer infrastructure, further justifying "a new residential zoning classification which allows single-family residential lots smaller and narrower than current standards allow" as noted in IV. Residential Land Use Supporting Policies (2) within the Ada Master Plan. An approval of the PUD will allow for a residential development which is of "size, scale, form, and placement that conforms with the planning and designing principles expressed in the Ada Village Design Charrette Final Report" as noted in the V. Ada Village Area Supporting Policies (4) within the Ada Master Plan. Building a neighborhood under the current zoning would require larger, more "estate sized" lots of 90' in width, which would not be compatible with the rest of Fase St or the intent of the Ada Master Plan.

The project is intended to be a site condominium with one single phase of construction. Homes are to be a variety of single-story ranch, or 'cape cod' style 2 story with optional finished basements. Home width is proposed to be 40' and length roughly 75'. Exterior materials to be regulated by developer's architectural review, with only quality materials acceptable. 2 (or potentially 3 on select lots) stall garages are to be front-load, but a covered front porch will be required to be set forward so as to minimize impact of garage façade. Side yard setbacks to be 7' and front porches will be set back 15' from the road. The homes will be similar in aesthetics and scale to the RiverPoint of Ada project, which has very similar dimensions' architectural details will vary slightly from RiverPoint, however.

The neighborhood will be serviced by a public road, the dimensions of which have been reviewed and deemed acceptable by the Kent County Road Commission. There are 2 areas of greenspace. One located on the 'island' created by the road and the other separating lots 8 & 9 shown on the site plan. It is the intent of the latter greenspace to create a visual buffer for the neighboring property owner at Ada Moorings as discussed in the pre-application conference. There are no known wetland or DEQ issues on the site, however a Due Care Plan was necessary to address contaminated soils on the site due to previous uses. Finally, a traffic analysis is enclosed documenting the minimal impact which this project will have on traffic through Fase St.

The applicant requests a PUD specifically for a 55' lot width minimum. The current zoning for the entirety of Fase St. (V-R) allows for such lot widths. The applicant argues that it is more appropriate to consider the site a part of Fase St. rather than and entirely different zone district.



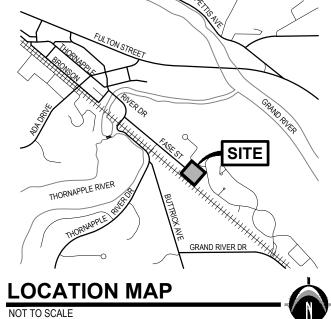


SCALE: 1" = 30'

BENCHMARKS

BENCHMARK "A" ELEV. = 638.38 (NGVD 29) Flange bolt on Hydrant under "East", located 31'± NE of centerline of Fase Street and 18'± SE of centerline of Emergency Access Drive.

BENCHMARK "B" ELEV. = 639.70 (NGVD 29) Flange bolt on Hydrant under "East", located 13'± Easterly of Edge of asphalt at curve in Moorings Drive

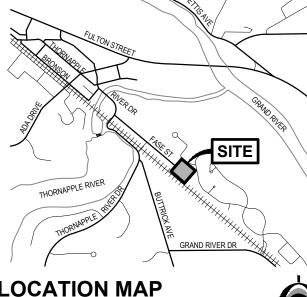

LEGEND

Iron - Found

PREPARED FOR:

— X — X — Fence

Existing Building



TITLE DESCRIPTION

Part of the Southeast 1/4, Section 34, Town 7 North, Range 10 West, described as Commencing on the Southerly line of Block 2 of the Village of South Ada extended 1 00 feet Southeasterly from the Southeasterly corner of Lot 12 of said Block; thence Northeasterly at right angles 400 feet; thence Southeasterly at right angles 435 feet; thence Southwesterly at right angles 400 feet to Grand Rapids Eastern (formerly Central Michigan, formerly GT) Railroad right of way; thence Northwesterly along right of way 435 feet to the place of



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INDIANAPOLIS ST. LOUIS

Mensa Capital

Chuck Hoyt

660 Ada Drive SE Suite 301 Ada, MI 49301

REVISIONS: Title: Prelim. PUD Review Drawn: JM Checked: KK Date: 06.18.20 Title: Prelim. PUD Submittal Drawn: JM Checked: KK Date: 12.14.20

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Existing

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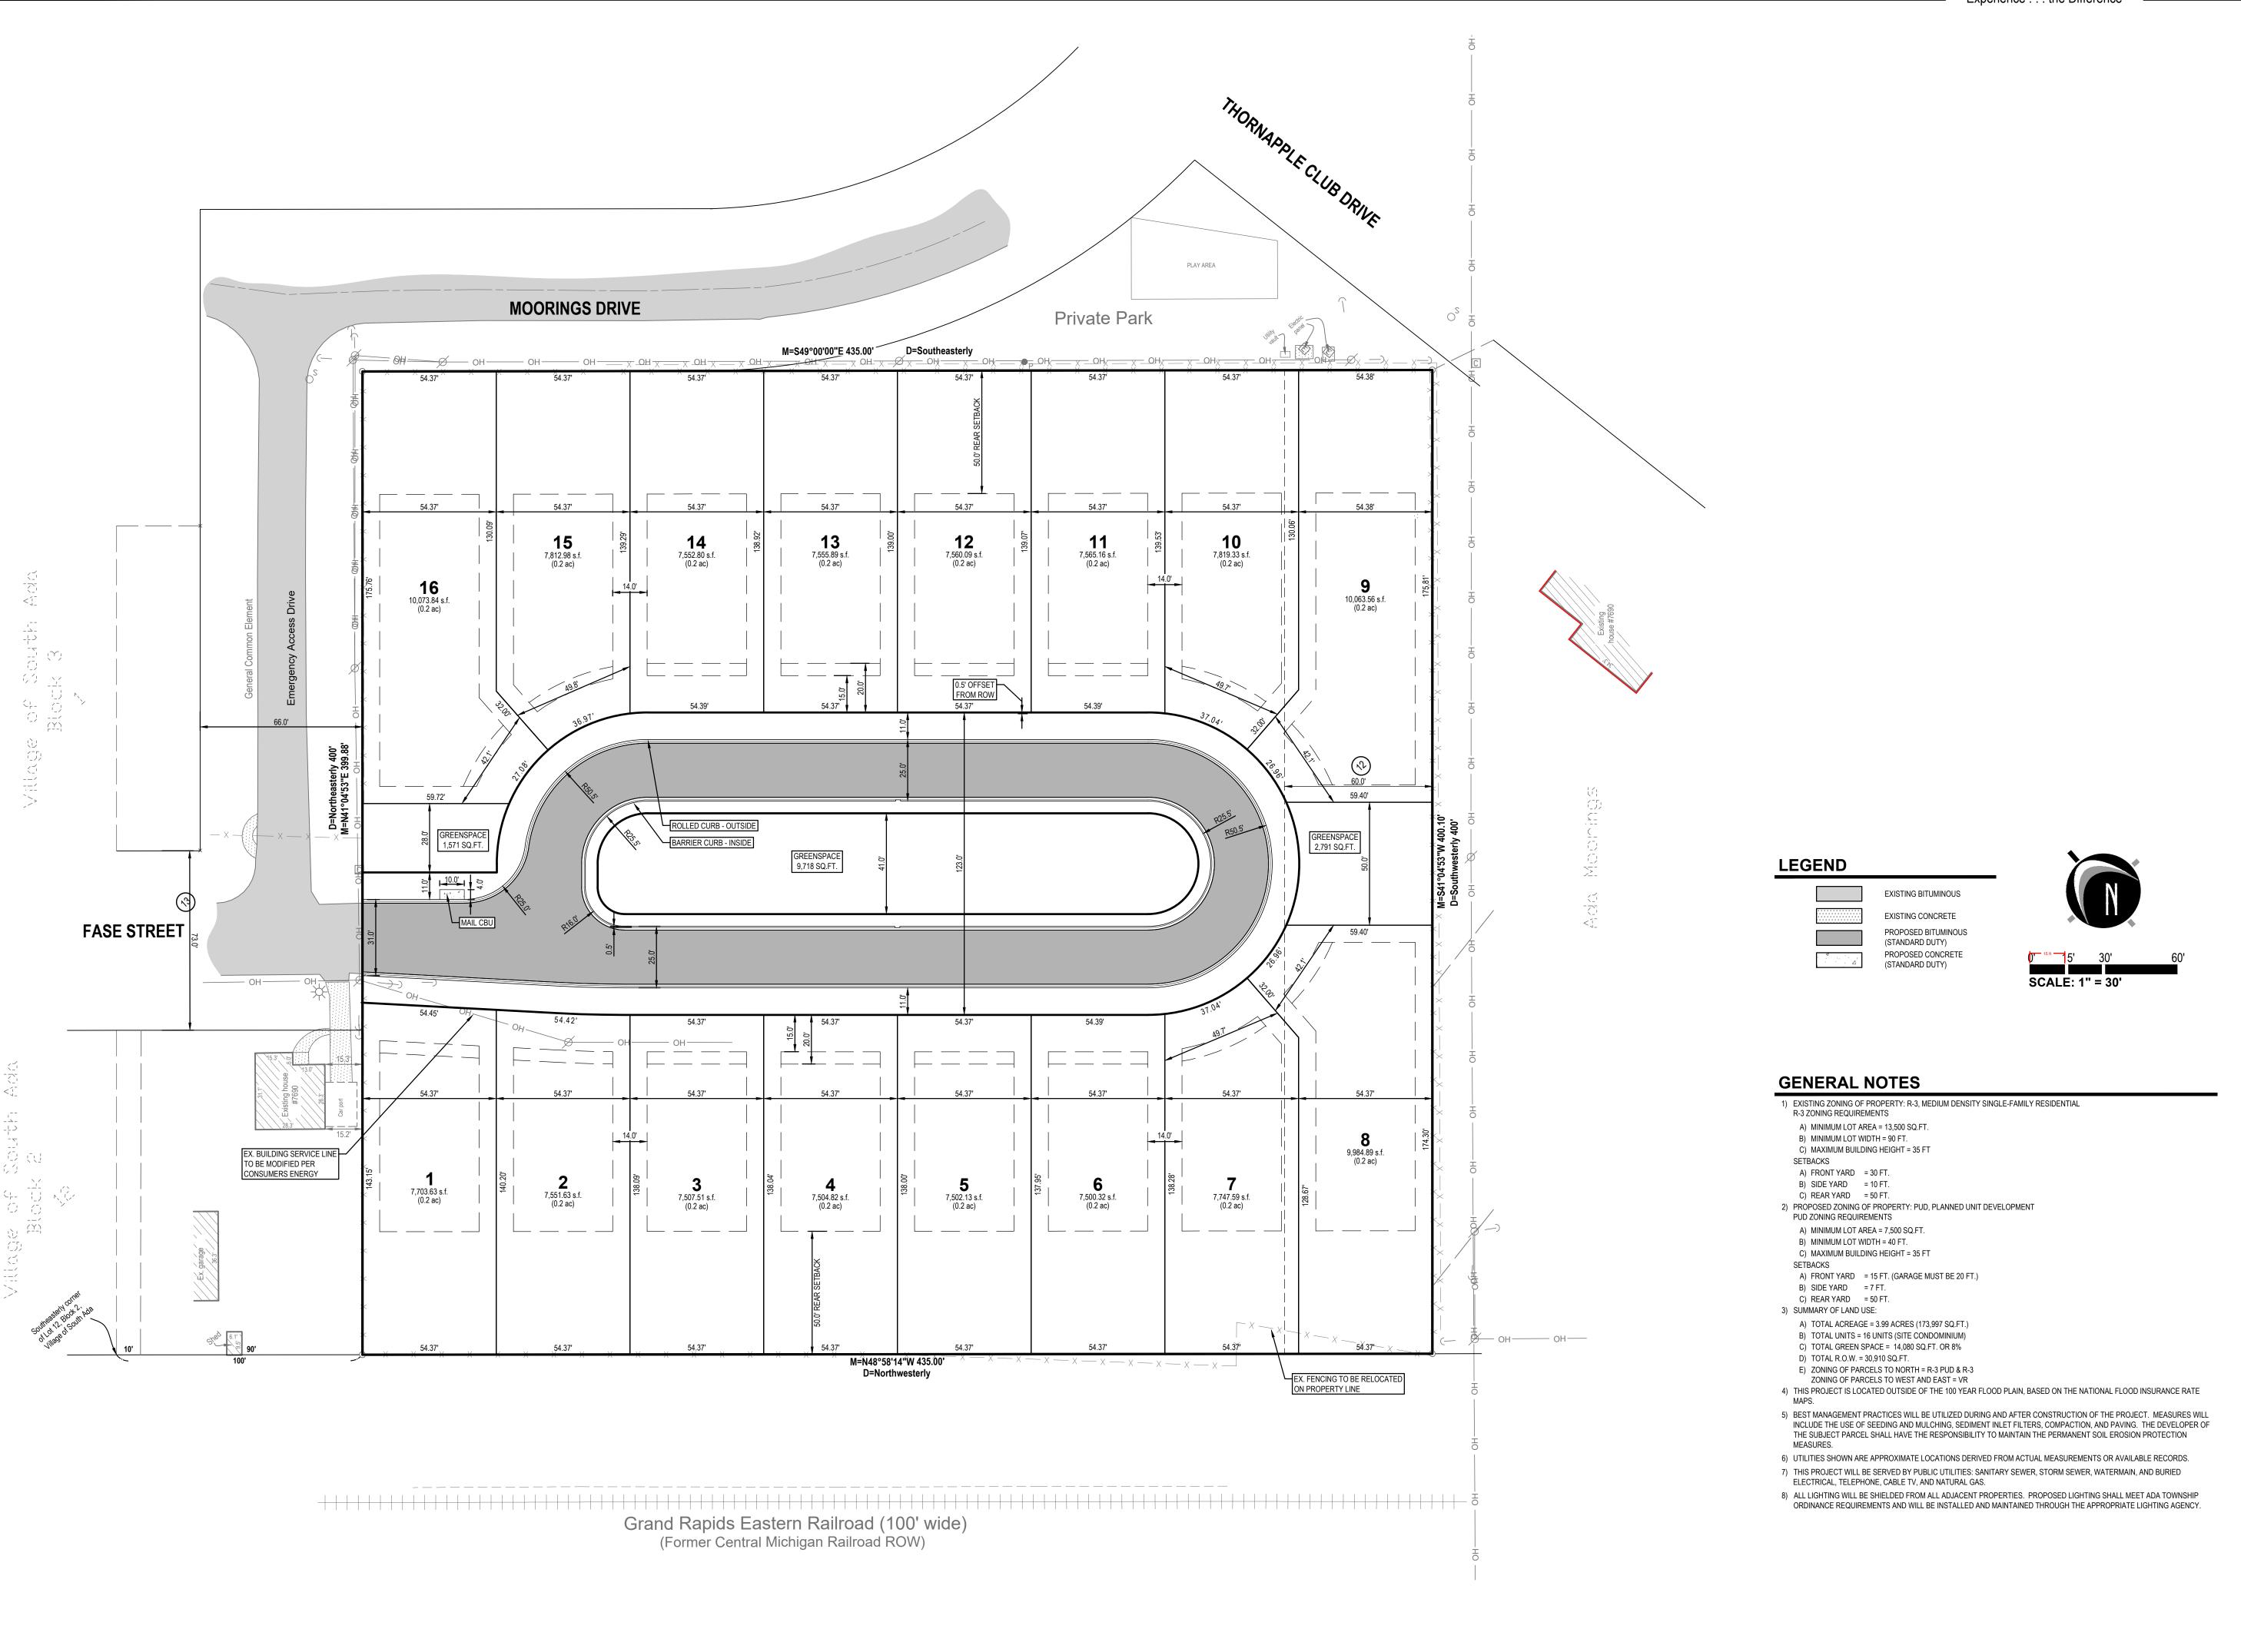
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PROJECT NO: 18400482

SHEET NO:

C-101



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PREPARED FOR:

Mensa Capital Chuck Hoyt

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Plan

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STAMP:

PROJECT NO: 18400482

SHEET NO:

C-102

9,984.89 s.f. (0.2 ac)

EX. FENCING TO BE RELOCATED ON PROPERTY LINE

7,747.59 s.f. (0.2 ac) NEDERVELD

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7699 FASE ST. PUD

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2 7,551.63 s.f. (0.2 ac)


EX. BUILDING SERVICE LINE TO BE MODIFIED PER CONSUMERS ENERGY

7,703.63 s.f. (0.2 ac)

Grand Rapids Eastern Railroad (100' wide) (Former Central Michigan Railroad ROW)

54.37' 54

Sample Architecture

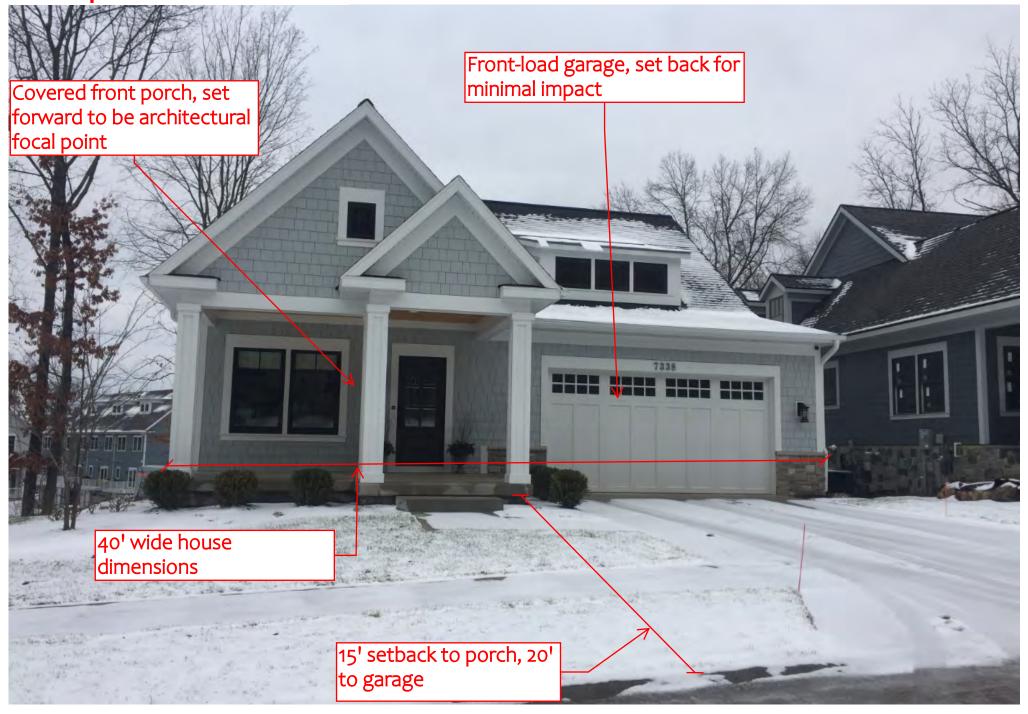



TRAFFIC ANALYSIS

7699 FASE STREET PROPOSED DEVELOPMENT

The following data was sourced from Trip Generation, 10th Edition (Institute of Transportation Engineers [ITE], 2017). This publication represents the industry standard for estimating trip generation and is based on a compilation of empirical trip generation surveys at locations throughout the country.


In the current 10th edition of Institute of Transportation Engineer's (ITE) Trip Generation Manual, the categorization for the proposed project would be considered single family detached residential (land use #210). Trip generation per day for detached, single family homes is estimated to be 10 trips per day, therefore, the total anticipated trips per day in a 16 unit development would be approximately 160. However, it is important to note that the 10th edition ITE manual no longer differentiates detached, single family condominiums from detached, single family units within a plat or site condominium. The last ITE manual that differentiated these uses was the 8th edition. In it, residential condominium trips rates were as low as 5.81 per unit. Using this calculation, the proposed project would anticipate approximately 93 trips per day.

The lower trip generation rate would be appropriate to use in this situation since the ITE manual does not take into account unit size, number of proposed bedrooms, or even anticipated number of residents per home. With the understanding that the proposed units will be smaller than a traditional, detached, single family residential unit and pursue a different target demographic, a lower trip generation rate more accurately reflects the end project and users.

Regardless of the trip generation multiplier used, traffic will increase on Fase Street with the addition of a new residential project. According to trip generation information provided by the Township, the approximate number of vehicles per day on Fase Street currently is 320. With the addition of the proposed project, the number of vehicles per day will grow by approximately 93 vehicles. Therefore, the total number of vehicles per day on Fase Street is estimated to increase to 413. This anticipated total number of vehicles is still well below the engineered design threshold of 1,000 vehicles per day for residential streets.

However, without the approval of the requested rezone, the parcel is still located in a highly desirable area and it can be expected that this site will be developed. As a R-3 zoned parcel, the site could support approximately 8 detached, single family homes in a plat or site condo. Utilizing the ITE trip generation statistics for a traditional, detached, single family home this would equate to approximately 80 trips per day under this scenario. Therefore, it can be supposed that nearly an equivalent number of vehicles will be added to Fase Street through either the rezoned condominium development or a more traditional single family home development. However, it is important to note

that a R-3 plat or site condo would likely yield larger homes with the option for three stall garages that would be out of context and out of character with the existing homes on Fase Street.

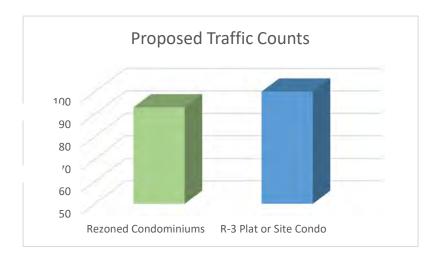



Last, it is also important to look at the greater traffic network to confirm that those roads have the appropriate engineering design and capacity to support an increase in traffic. The Grand Valley Metro Council (GVMC) maintains historic traffic count data in Kent County and the 2017 traffic volume count for Thornapple River Drive, north of Buttrick totaled 12,558. Therefore, assuming 93 additional trips per day are put onto Thornapple River Drive, the result is less than a one (1) percent increase in traffic in the greater road network.


Summary

Current Zoning: 80 Trips/Day

Proposed PUD: 93 Trips/Day

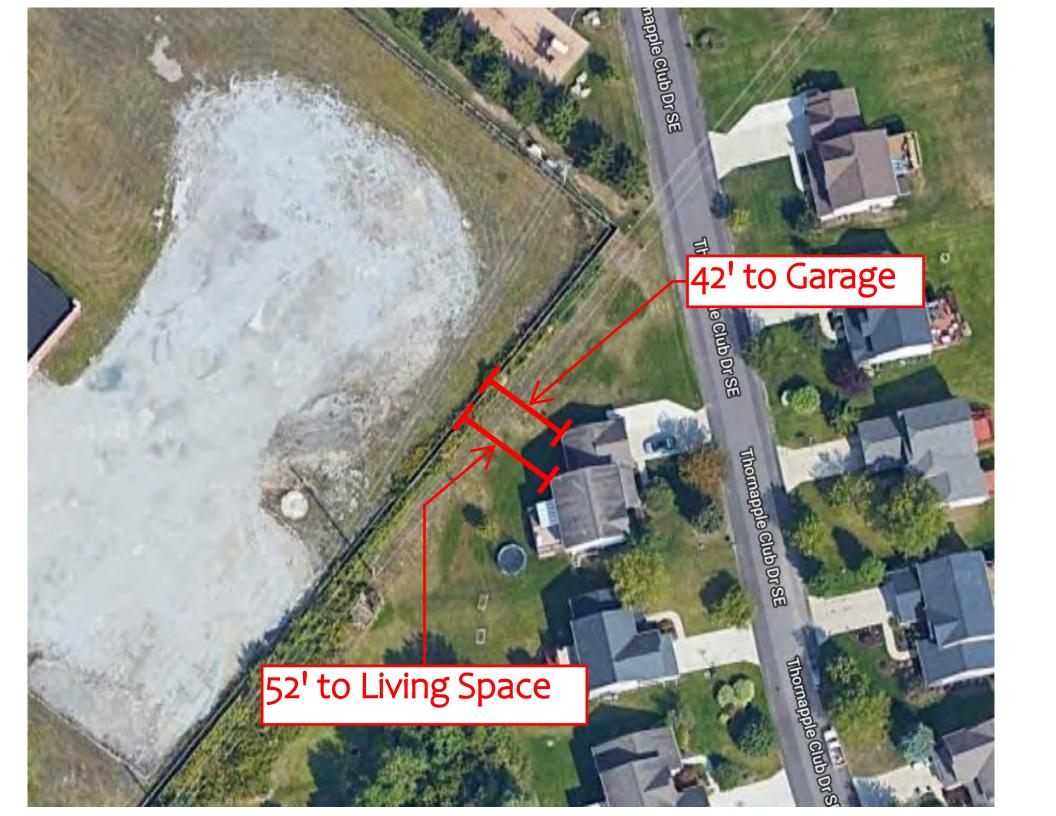


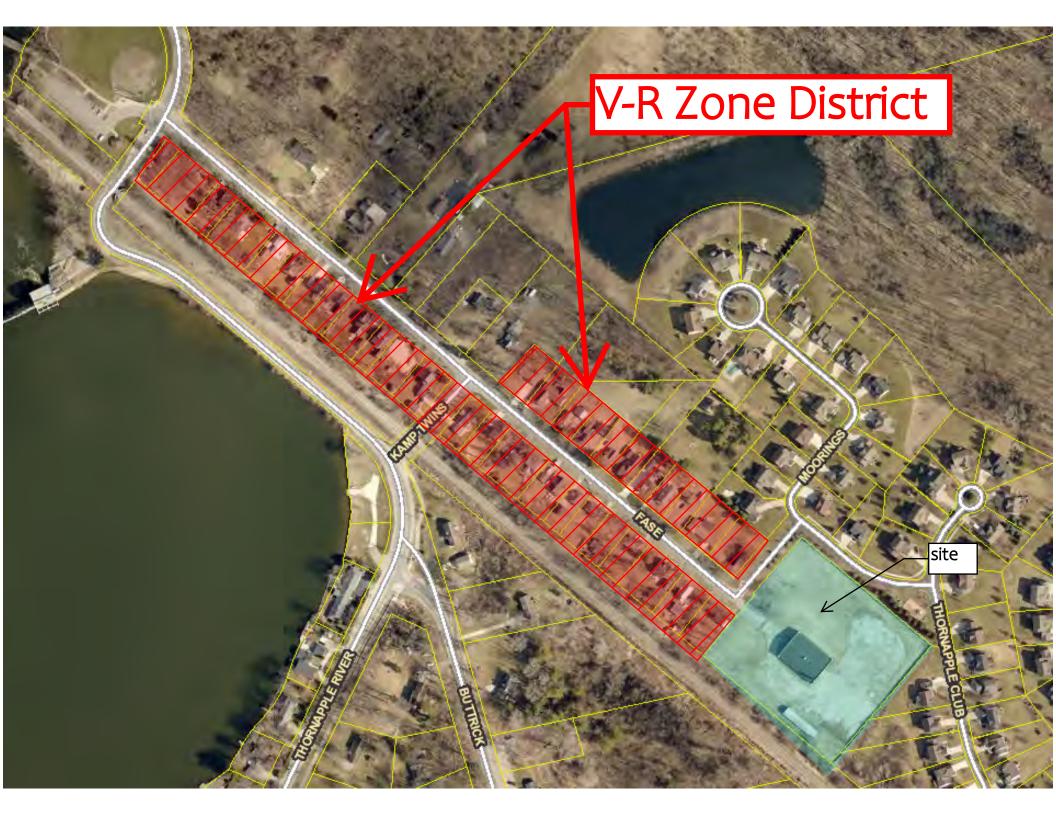

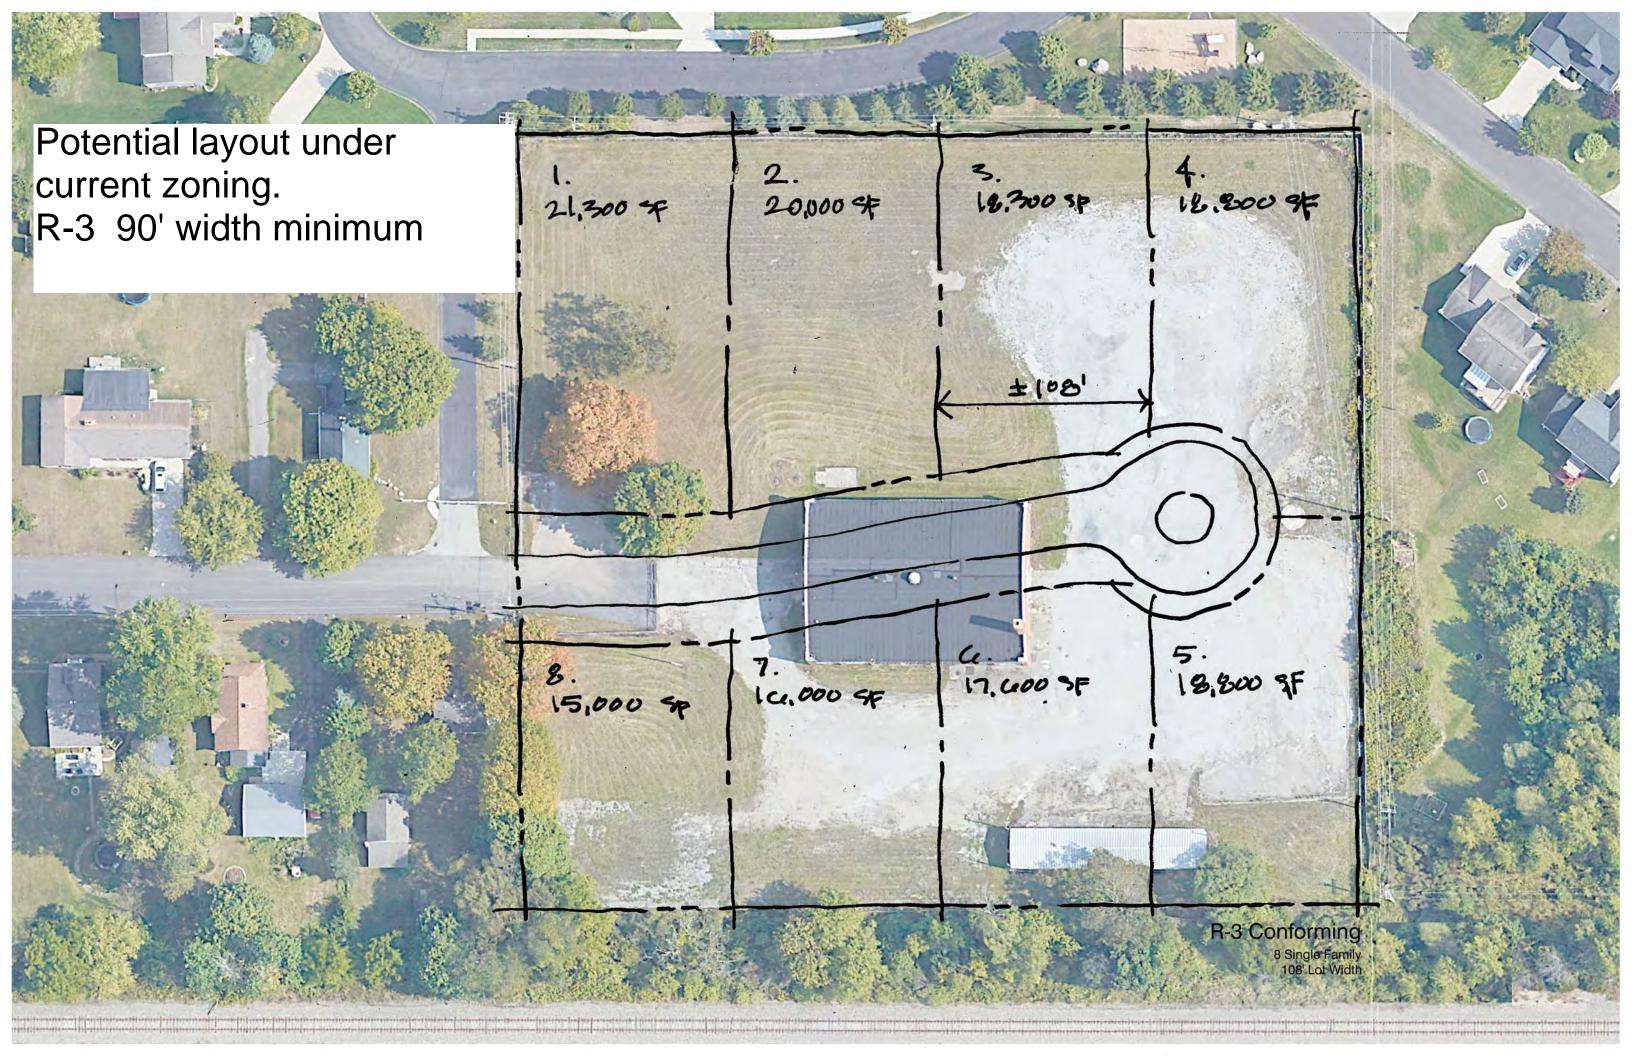



72' Wide House

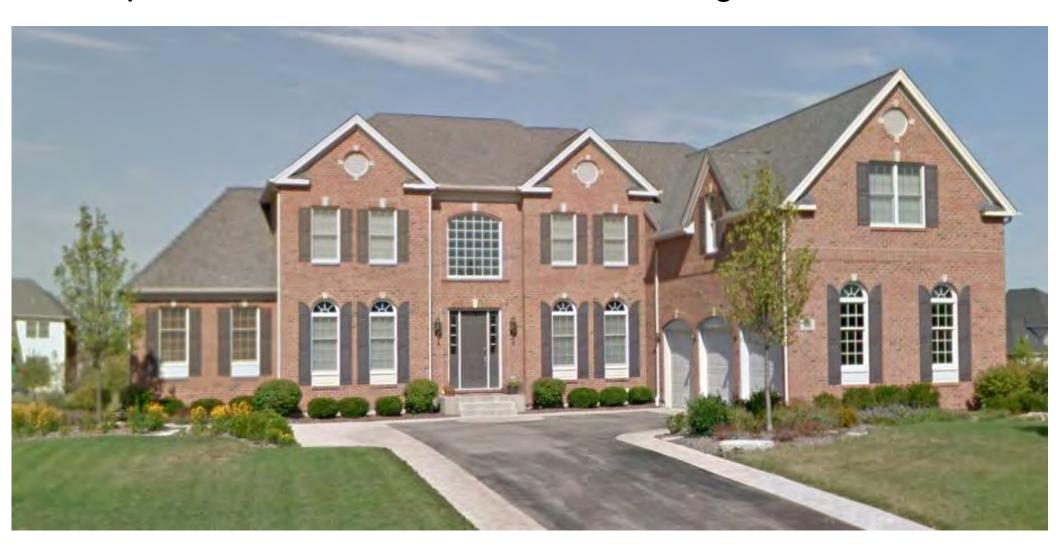

70 Wide House



62' Wide House

